# Ware-Lyndon House Historic Garden

## Athens-Clarke County, Georgia

Issued: DECEMBER 01, 2014

## Construction Plans - Pricing Set

#### **OWNER:**

Athens-Clarke County SPLOST Program Management 301 College Ave, Rm 101 Athens, GA 30601

24-HOUR CONTACT: Keith Sanders, Project Administrator PH: (706) 613-3025

#### LANDSCAPE ARCHITECT:



Root Design Studio, LLC


5099 Woodridge Way Tucker, GA 30084 404-895-2253 mkidd@RootDStudio.com

### In Partnership with:

ATHENS DESIGN STUDIO 109 Westover Drive Athens, GA 30606

and

Mack R. Cain, RLA, LEED AP 3472 Desoto Ridge Trail Buford, GA 30519

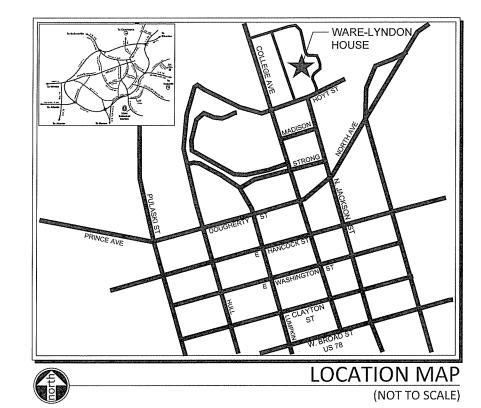

#### **PROJECT NOTES:**

- Project is located in the City of Athens, Clarke County, Georgia.
- All work shall be performed in accordance with applicable Federal, State and Local laws, codes, and regulations, as well as the most current version of the ADA Standards for Accessible Design.
- 3. The Contractor shall secure all necessary permits prior to beginning work.
- 4. The Contractor shall contact the Utility Protection Service (811) to locate all above and below ground utilities prior to beginning work.


#### **SHEET INDEX:**

	COVER
L-01	SURVEY / EXISTING CONDITIONS & GENERAL NOTE:
L-02	TREE PROTECTION & EROSION CONTROL PLAN
L-03	DEMOLITION PLAN
L-04	GRADING & DRAINAGE PLAN
L-05	LAYOUT PLAN
L-06	CONSTRUCTION DETAILS
L-07	CONSTRUCTION DETAILS
L-08	CONSTRUCTION DETAILS
I-01	IRRIGATION PLANS
I-02	IRRIGATION PLANS
I-03	IRRIGATION PLANS
I-04	IRRIGATION PLANS
1-05	IRRIGATION PLANS

#### **REVISIONS:**

No.	Date	Description
	[	



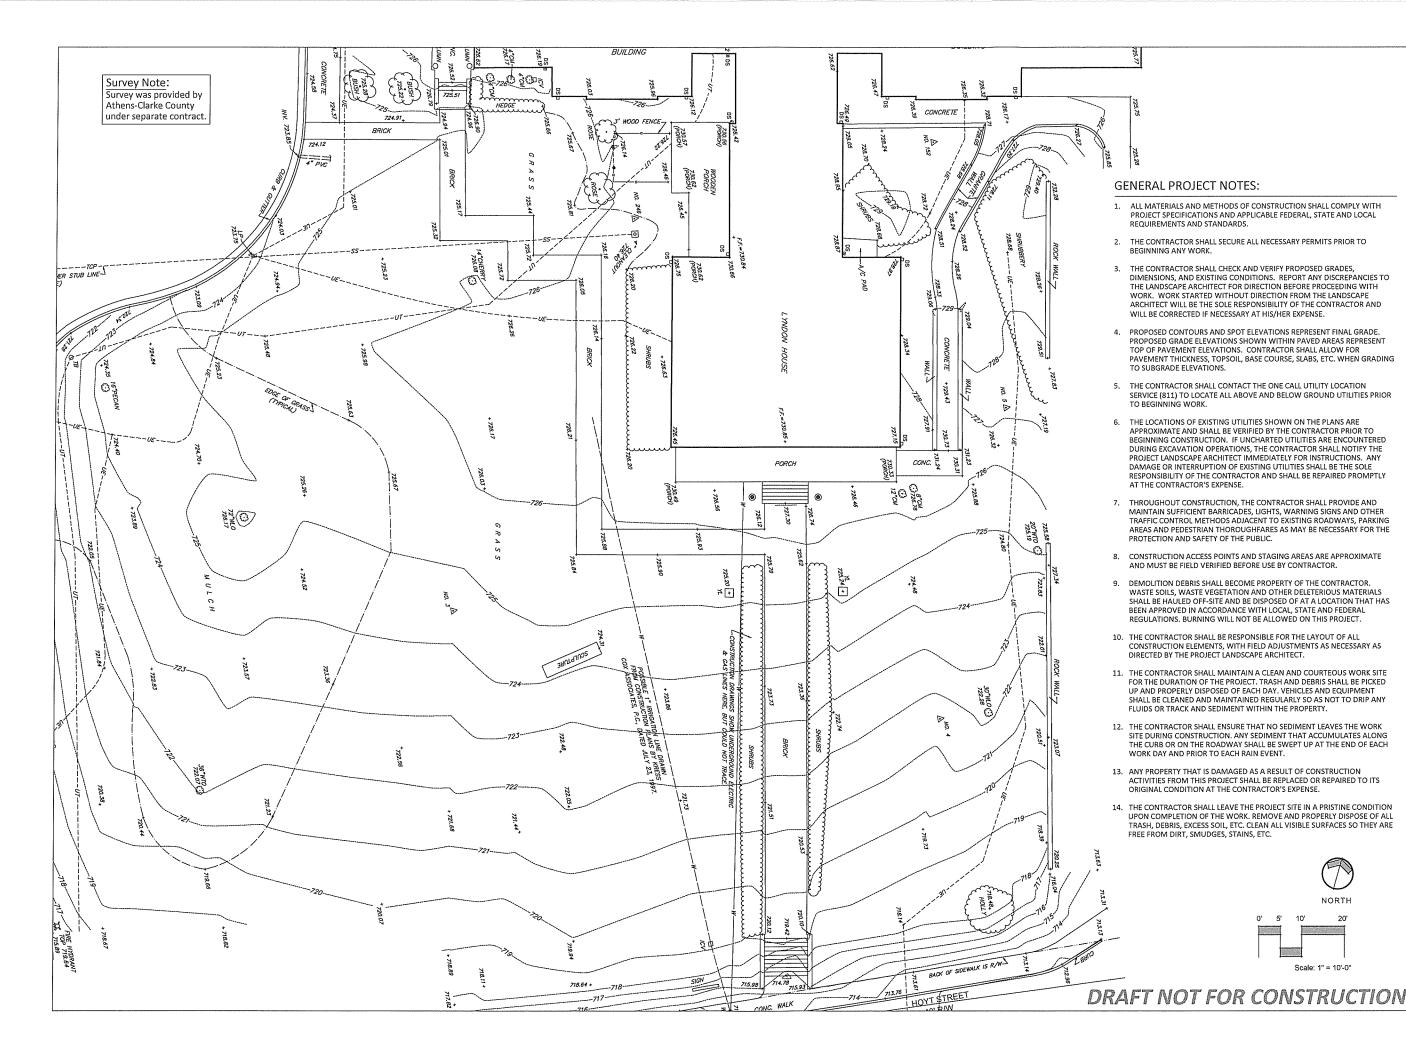



Date:	12.01.2014
Project No:	2014-011
Drawn By:	MF
Checked By:	мк

cab

Landso

e-Lyndon


ar


-Lyndon House Front Lands
Athens, Georgia
Athens-Clarke County Unified Government
293 Hoyt Street
Athens, GA 30606


Sheet Title: Survey/ Ex. Conditions & General Notes


Sheet No:


L-01

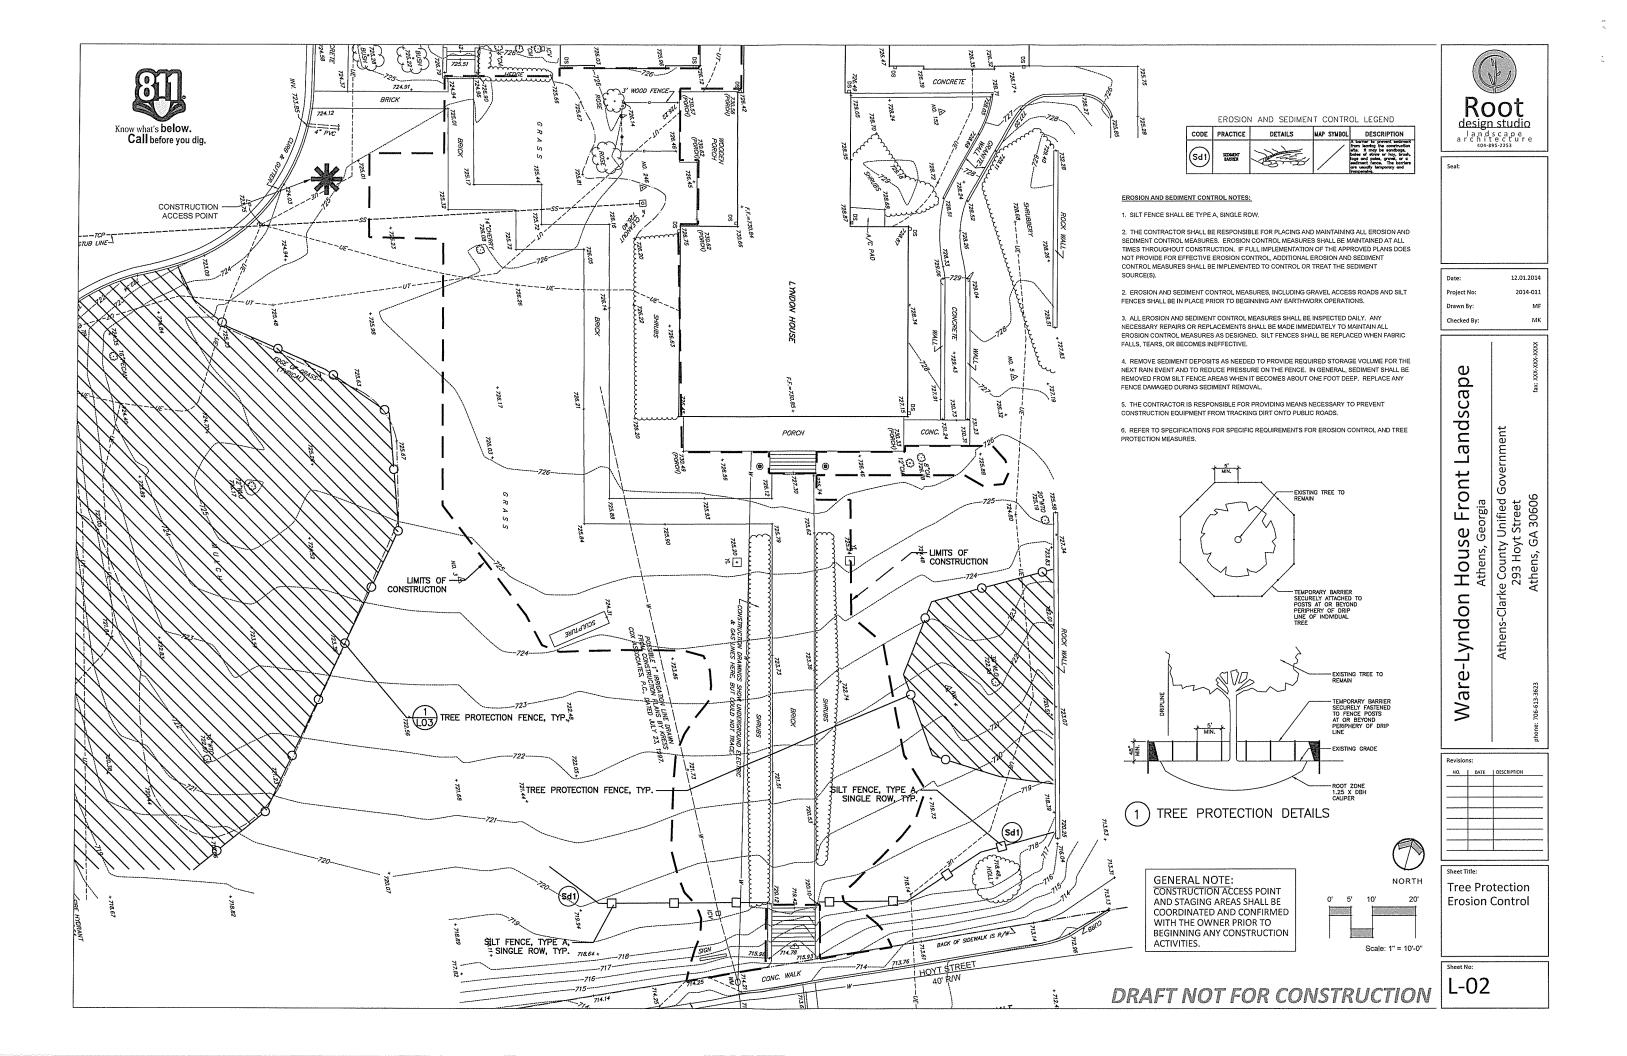

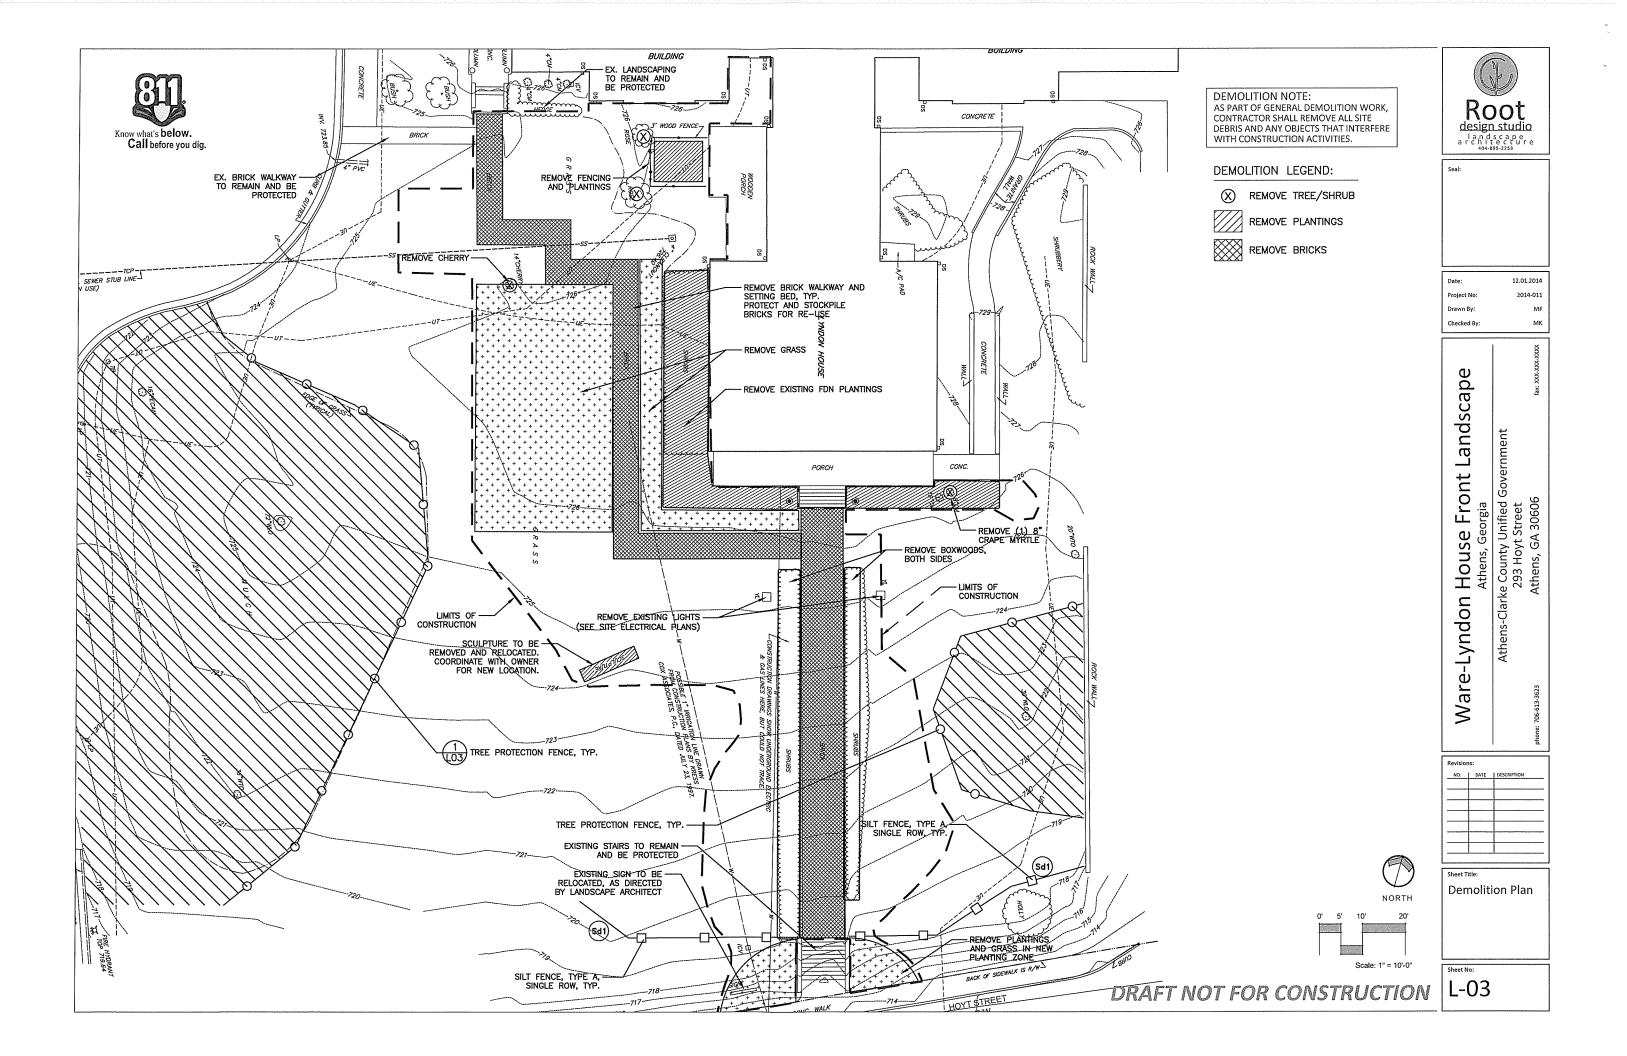

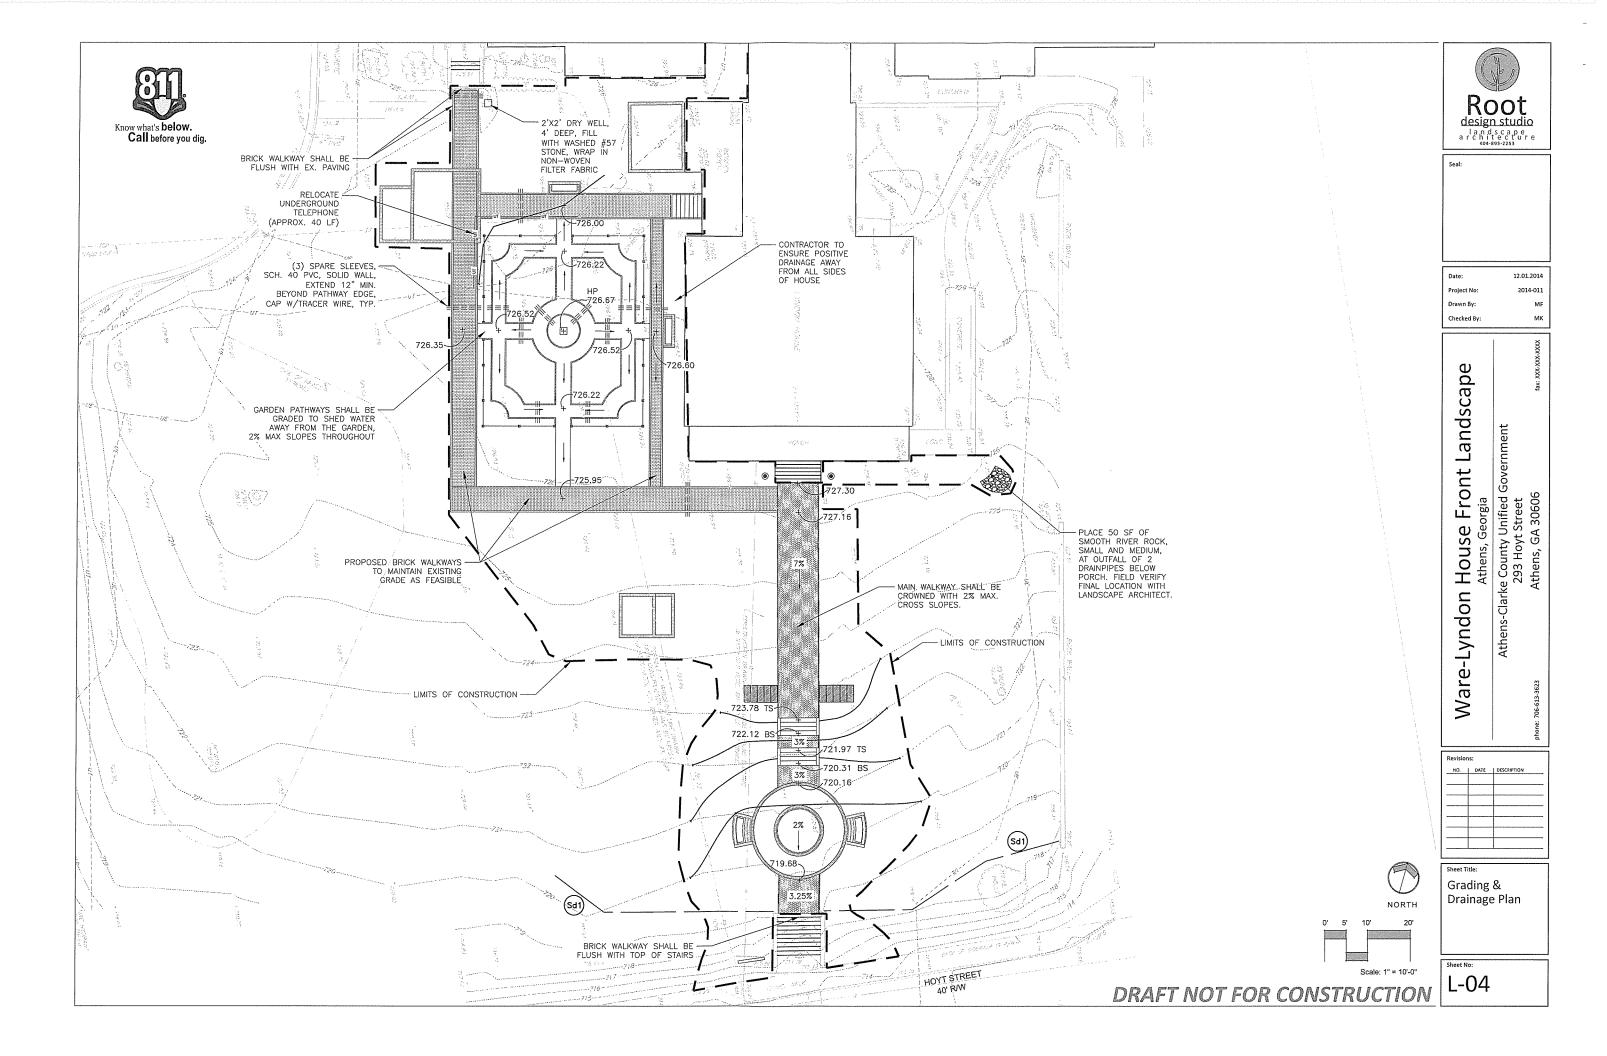

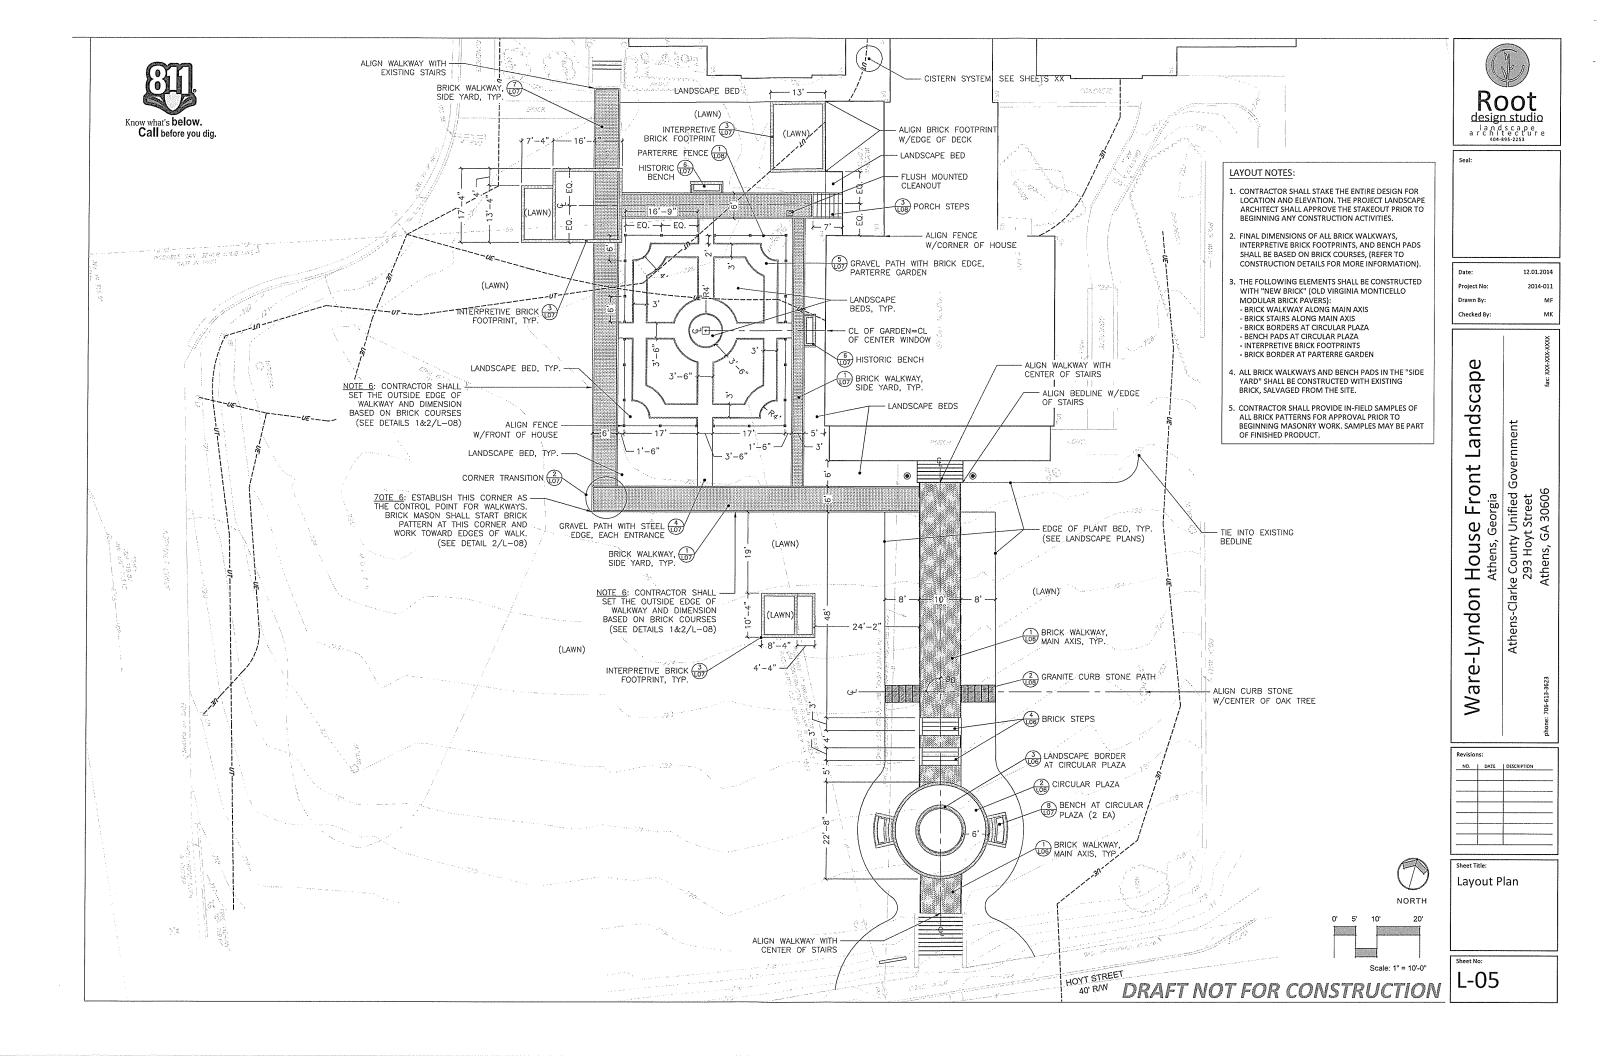

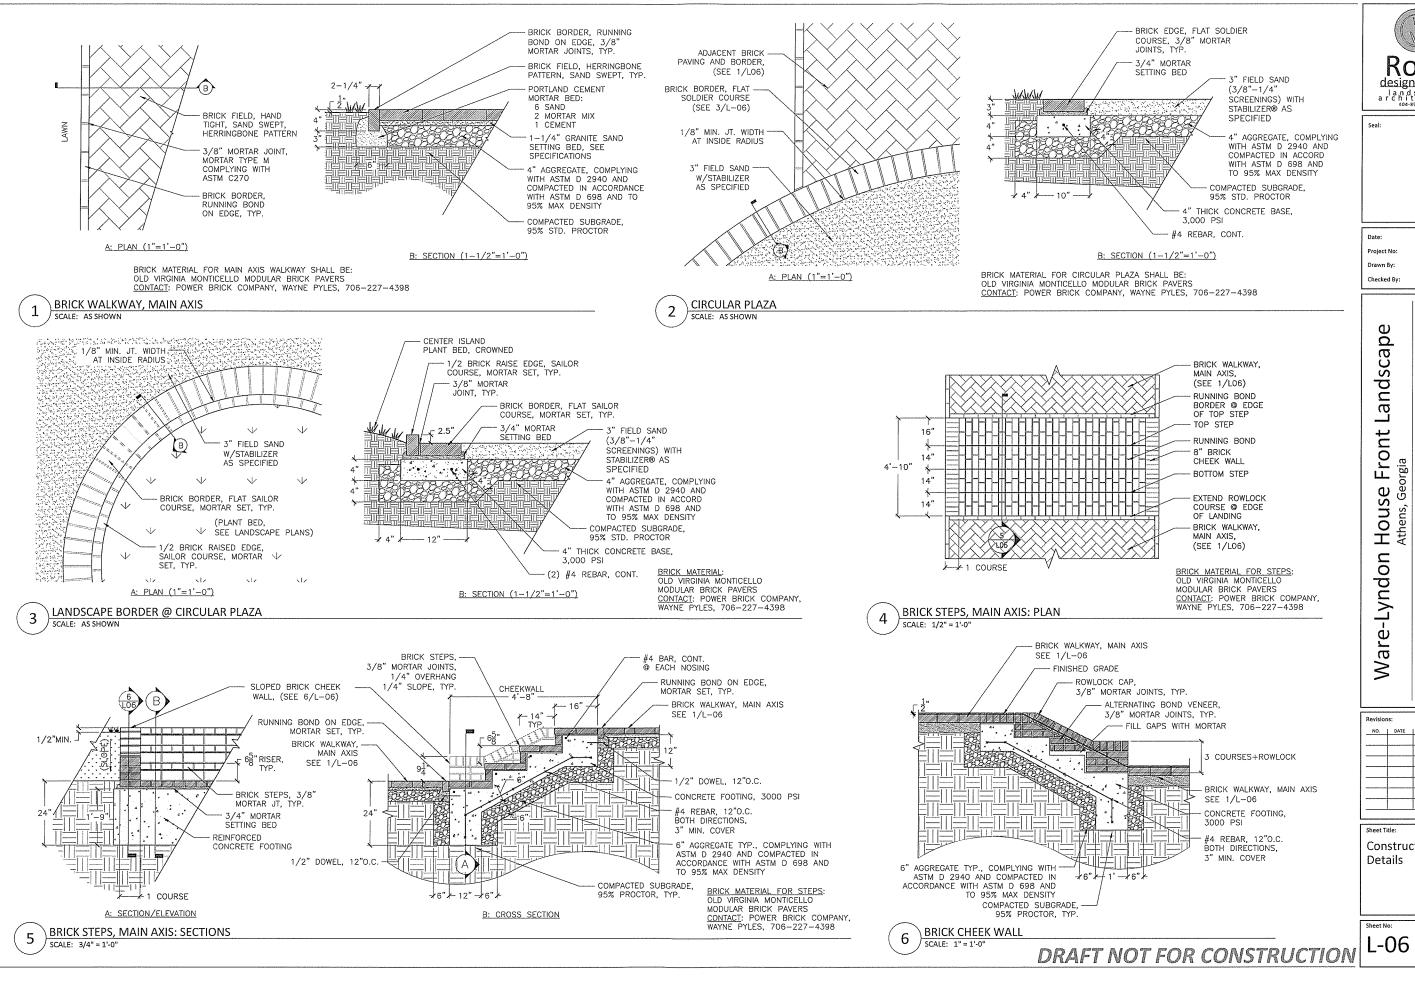



Root design studio landscape architecture

12.01.2014 2014-013 MK


Government larke County Unified G 293 Hoyt Street Athens, GA 30606

Construction

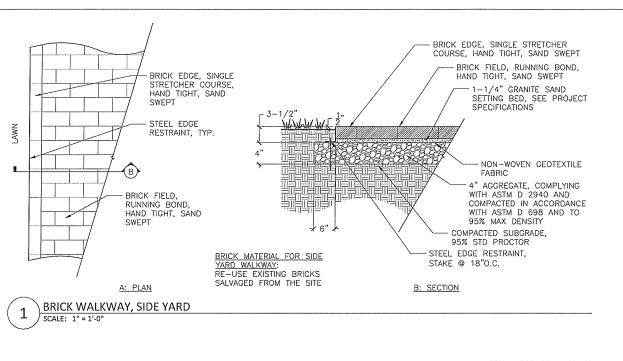

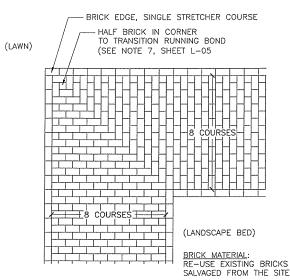

SALVAGED FROM THE SITE BRICK WALKWAY, SIDE YARD: CORNER TRANSITION

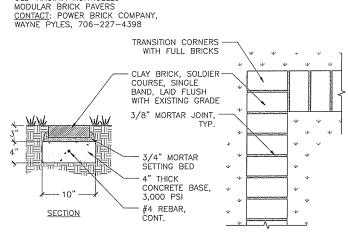

BRICK MATERIAL FOR INTERPRETIVE FOOTPRINT:

OLD VIRGINIA MONTICELLO


SCALE: 1-1/2" = 1'-0"

Checked By: <u>PLAN</u> INTERPRETIVE BRICK FOOTPRINT


STEEL EDGE RESTRAINT, STAKE @ 18"O.C. 3" FIELD SAND (3/8"-1/4" SCREENINGS) WITH STABILIZER® AS SPECIFIED 4" AGGREGATE, COMPLYING WITH ASTM D 2940 AND COMPACTED IN ACCORDANCE WITH ASTM D 698 AND TO 95% MAX DENSITY COMPACTED SUBGRADE

**GRAVEL PATH WITH STEEL EDGE** 4 SCALE: 1-1/2" = 1'-0"


BRICK MATERIAL FOR BRICK EDGE @ PARTERRE:
OLD VIRGINIA MONTICELLO MODULAR BRICK PAVERS
CONTACT: POWER BRICK COMPANY, WAYNE PYLES, 706-227-4398

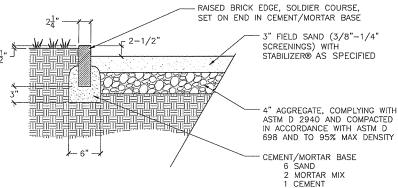


GRAVEL PATH WITH BRICK EDGE, PARTERRE GARDEN 5 SCALE: 1-1/2" = 1'-0"

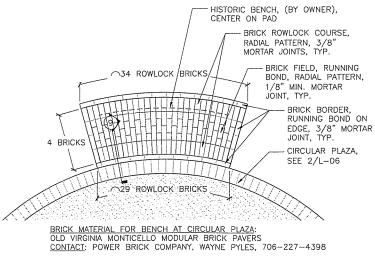

BENCH @ CIRCULAR PLAZA SCALE: 1/2" = 1'-0"

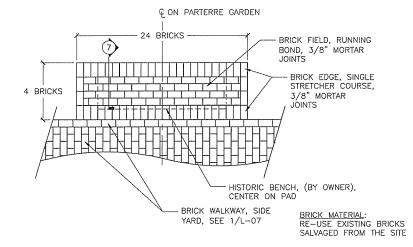

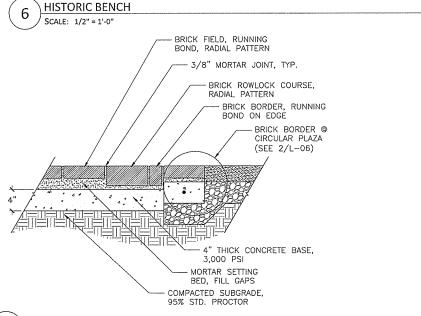

BENCH @ CIRCULAR PLAZA: SECTION SCALE: 1-1/2" = 1'-0"


Root design studio landscape architecture 404-895-2253

12.01.2014 2014-011 MK


scal Land Front larke County Unified G 293 Hoyt Street Athens, GA 30606 Georgia House Athens, ( are-Lyndon  $\geq$ 

Sheet Title: Construction Details

L-07

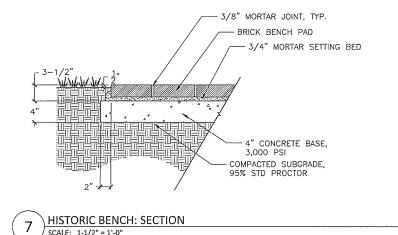

DRAFT NOT FOR CONSTRUCTION

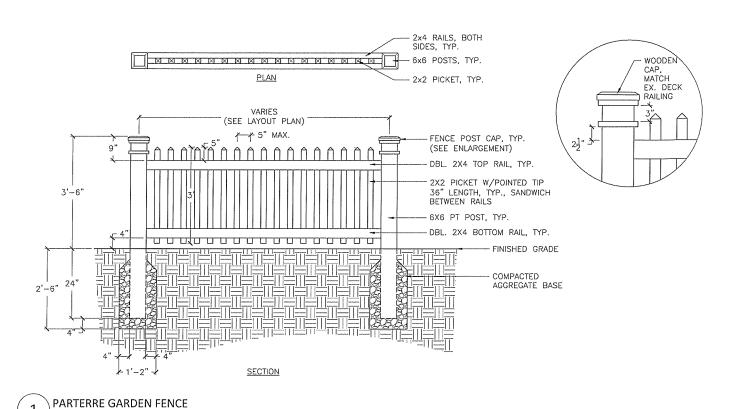

BUTT JOINT, HAND TIGHT, SAND SWEPT NOTE: CURBSTONES WILL BE PROVIDED BY THE OWNER 6"x18"x48" GRANITE CURB STONE, (SUPPLIED BY OWNER) 1-1/4" GRANITE SAND SETTING BED TRANSITION BETWEEN CURB STONE AND BRICK SHALL BE FLUSH AND SMOOTH BRICK WALKWAY, MAIN AXIS (SEE 1/L-07) - 4" COMPACTED AGGREGATE BASE COMPACTED SUBGRADE, 95% STD. PROCTOR


GRANITE CURB STONE PATH

- 2x6 STEP BOARD, TYP. 2X12 STRINGER, TYP. - BRICK WALKWAY, SIDE YARD (SEE 1/L-07) 6" THICK CONCRETE BASE, 3,000 PSI COMPACTED SUBGRADE,

SCALE: 3/4" = 1'-0"

**PORCH STEPS** 

SCALE: 1" = 1'-0"

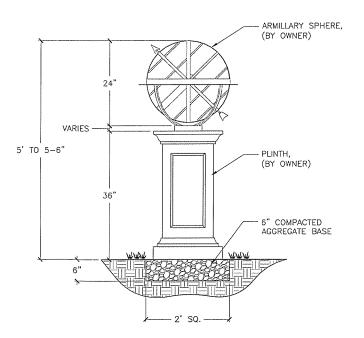


ARMILLARY SCULPTURE

Root design studio landscape architecture

10.25.2014 Date: 2014-011 Project No: Drawn By: MK Checked By:

Ware-Lyndon House Front Landscape Government s-Clarke County Unified G 293 Hoyt Street Athens, GA 30606 Athens, Georgia

Construction Details

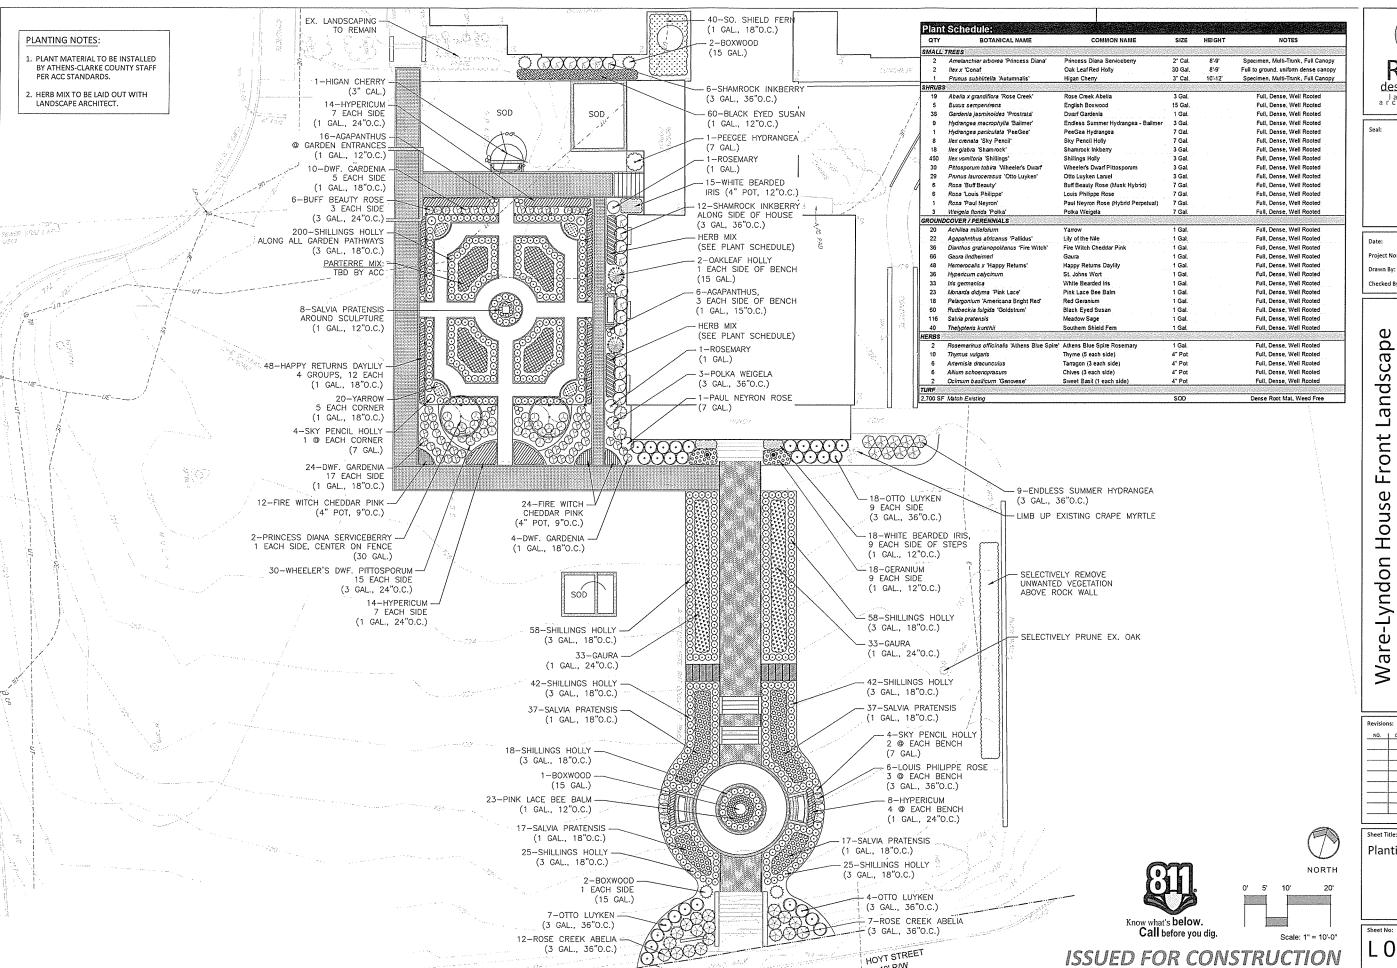




11.25.2014 2014-011 rawn By: Checked By:

Landscap Government Front s-Clarke County Unified Garants 293 Hoyt Street Athens, GA 30606 House Athens, Geo Ware-Lyndon



Planting Plan

\_ 09

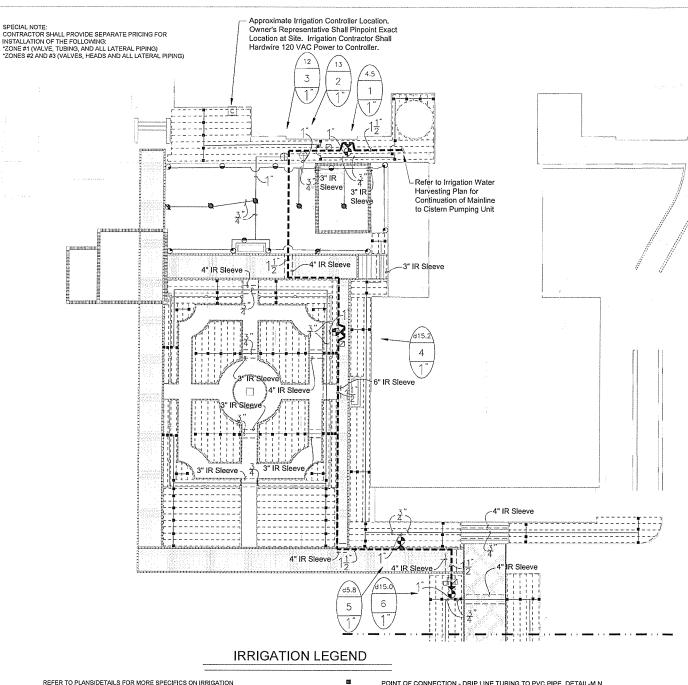

REFER TO PLANS/DETAILS FOR MORE SPECIFICS ON IRRIGATION WATER HARVESTING SYSTEM. INCLUDES CISTERN (ABOVE AND BELOW GROUND), CISTERN PUMPING UNIT, TRANSFER PUMPING UNIT AND ALL ASSOCIATED EQUIPMENT.

4 MANUAL DRAIN VALVE, SCH 80 PVC TRUE UNION BALL VALVE, DETAIL-E,

RAIN BIRD ESP-16-LXME CONTROLLER: 16 STATION, MODULAR CONTROLLER, FOUR PROGRAMS, WALL MOUNTED, DETAIL-F, IRRIGATION CONTRACTOR SHALL ALSO INISTALL A WIRELESS MINII CLIK II RAIN SENSOR AND A FREEZE-CLIK DEVICE. C

RAIN BIRD 100-PEB-PRS PLASTIC ELECTRIC REMOTE CONTROL VALVE, 1" SIZE, MOUNTED WITH SCH 80 PVC TRUE UNION BALL VALVE WITH PRESSURE REGULATION DEVICES, DETAIL-A.  $\oplus$ 

RAIN BIRD 1806-SAM, 6" POP-UP LAWN SPRAY SPRINKLER, 12' RADIUS, FULL-2.0 GPM, HALF-1.0 GPM, QUARTER-0.5 GPM, 30 PSI. DETAIL-C. **95**0 

RAIN BIRD 1806-SAM, 6" POP-UP LAWN SPRAY SPRINKLER, 15' RADIUS, FULL-4.0 GPM, HALF-2.0 GPM, QUARTER-1.0 GPM, 30 PSI. DETAIL-C. RAIN BIRD 1806-SAM, 6" LAWN POP-UP SIDE STRIP SPRAY SPRINKLER, 9' X 18' RADIUS, 1.5 GPM, 30 PSI. DETAIL-C.

RAIN BIRD 1806-SAM, 6" LAWN SIDE STRIP SPRAY SPRINKLER, 4" X 30" RADIUS, 1.5 GPM, 30 PSI. DETAIL-C.  $\odot$ 

O

4

RAIN BIRD 1806-SAM, 6" LAWN END STRIP SPRAY SPRINKLER, 4' X 15'  $\bigcirc$ 

RAIN BIRD #5 QUICK COUPLING VALVE 1" SIZE, CONTRACTOR TO SUPPLY TWO QCV KEYS AND MATCHING HOSE SWIVELS, DETAIL-B.

SCH 80 PVC TRUE UNION BALL VALVE, SIZED SAME AS MAINLINE, MOUNTED IN CARSON VALVE BOX, DETAIL-D. 1 RAIN BIRD DRIP ZONE ASSEMBLY KIT, MODEL #XCZ-100-PRB-COM . 1'

POINT OF CONNECTION - DRIP LINE TUBING TO PVC PIPE, DETAIL-M,N.

DRIP TUBING: RAIN BIRD XFS DRIPLINE DRIP TUBING, .6 GPH, 12" CENTERS, STAKED EVERY TURN OR EVERY 4', INSTALL NETAFIM AIR RELIEF VALVE KIT IN 10" CIRCULAR VALVE BOX AT HIGH POINT OF EACH ZONE AND INSTALL NETAFIM DRIP DRAIN VALVE(S) IN 10" CIRCULAR VALVE BOX AT LOW POINT(S) OF EACH ZONE. INSTALL RAIN BIRD DRIP OPERATING KIT AT EACH END OF ALL DRIP ZONE AREAS, DETAIL-F.M.N.O.P.Q.

MAINLINE PIPE: 1-1/2" SIZE IF NOT NOTED, CLASS 200 PVC

IRRIGATION SLEEVE: CLASS 200 PVC, SIZE NOTED ON PLAN, DETAIL-H,

LATERAL LINE PIPE: CLASS 200 PVC, SIZE NOTED.

-- -- - 3" ELECTRICAL CONDUIT SLEEVE.

- 1. ALL SPRINKLERS WILL BE MOUNTED ON (3) MARLEX STREET ELLS WITH A
- SCHED. 80 NIPPLE SIZE OF SPRINKLER INLET.
  2. CONTRACTOR TO UTILIZE A AUTOMATIC DRAIN CHECK VALVE DEVICE
- WHERE LOW HEAD DRAINAGE MAY OCCUR. 3. ALL WIRE WILL BE COLOR CODED DIRECT BURIAL UL/UF WIRE: COMMON
- (WHITE) #12-1, CONTROL (RED) #14-1, 4. ALL PIPING AND WIRING UNDER HARDTOPS WILL BE IN CLASS 200 PVC PIPE SLEEVE

#### TYPICAL VALVE INDICATOR



GALLONS PER MIN

STATION NUMBER VALVE SIZE

#### **GENERAL NOTES**

- ALL MAINLINES TO HAVE A MINIMUM OF 18" OF COVER, (CLASS 200 PVC PIPE), ALL LATERAL AND SUB-MAIN PIPE TO HAVE A MINIMUM OF 12" OF COVER, (CLASS 200 PVC PIPE).

  NO ROCKS, BOULDER, OR OTHER EXTRANEOUS MATERIALS TO BE USED IN BACKFILLING OF TRENCH.
  ALL PIPE TO BE INSTALLED AS PER MANUFACTURERS' SPECIFICATIONS, ALL THREADED JOINTS TO BE COATED WITH TEFLON TAPE OR LIQUID

- TEFLON.

  6. ALL LINES TO BE THOROUGHLY FLUSHED BEFORE INSTALLATION OF
- SPRINKLER HEADS.
  SPRINKLER AND RELATED EQUIPMENT TO BE INSTALLED AS PER DETAILS. ALL ELECTRICAL JOINTS TO BE MADE USING WATERPROOF CONNECTIONS AS
- SHOWN ON DETAILS.

  9. ALL EQUIPMENT NOT SPECIFIED IN THE LEGEND SHALL BE DETERMINED AND
- FURNISHED BY THE CONTRACTOR,

  10. NO ELECTRICAL CONNECTIONS SHALL BE MADE IN THE FIELD EXCEPT AT A VALVE CONTROL BOX OR ANOTHER VALVE BOX SPECIFICALLY FOR CONNECTIONS
- 11. ANY DISCREPANCY BETWEEN THIS SHEET AND OTHERS IN THIS SET MUST BE
- 11. ANY DISCREPANCY BETWEEN THIS SHEET AND OTHERS IN THIS SET MUST BE REFERED TO THE HERIGATION CONSULTANT BY THE CONTRACTOR FOR CLARIFICATION BEFORE PRECEDING WITH THE WORK.

  12. ALL 24 VOLT WINES SHALL BE #12 UFULL FOR COMMON WIRE, AND #14 UF/UL FOR CONTROL WINES, DIRECT BURIAL, SOLID COPPER.

  13. CONTRACTOR TO BE RESPONSIBLE FOR PROPER COVERAGE OF AREAS TO BE WATERED. IE, ADJUST HEADS WITH INSUFFICIENT COVERAGE DUE TO BLOCKAGE BY EXISTING OR PROPOSED SITE FEATURES.

  14. CONTRACTOR TO REFER TO LANDSCAPE PLANT TO KEEP SPRINKLER EQUIPMENT AND ACCESSORY MATERIAL FROM INTERFERING WITH PROPER PLANTING, I.e. VERIFY ROOT BALL SIZE FOR PLANTING.

  15. CONTRACTOR SHALL PROVIDE EXPANSION COILS AT EACH WIRE CONNECTION IN VALVE BOX (WINAP AROUND) 36" PIPE 12 TIMES).

  16. CONTRACTOR TO UTILIZE APPROPRIATE AUTOMATIC DRAIN DEVICE WHERE LOW HEAD DRAININGE MAY OCCUR.

- LOW HEAD DRAINAGE MAY OCCUR.
  ALL SPRINKLERS TO BE MOUNTED ON SWING JOINTS REFER TO DETAILS. 18. CONTRACTOR SHALL UTILIZE VALVE I.D. TAGS ON ALL REMOTE CONTROL
- 19. 24 VOLT WIRE SHALL BE COLOR CODED: COMMON-WHITE, CONTROL-RED. 20. CONTRACTOR SHALL INSTALL MANUFACTURERS' RECOMMENDED GROUNDING EQUIPMENT FOR POWER SUPPLY AND VALVE OUTPUT WITH
- (2) 5/8" COPPER CLAD GROUND RODS. 21. CONTRACTOR SHALL INSTALL MANUFACTURERS' RECOMMENDATION ON FAULT GROUND AND LIGHTNING PROTECTION.
- 22. CONTROLLER GROUNDING MUST BE AS PER ASIC REQUIREMENTS

- 23. ALL MATERIAL TO BE SUPPLIED BY CONTRACTOR TO OWNER:

  A. TWO WRENCHES FOR DISASSEMBLING AND ADJUSTING EACH TYPE OF SPRINKLER HEADS AND VALUE SUPPLIED.

  B. TWO KEYS FOR EACH OF THE AUTOMATIC CONTROLLERS.

  C. TWO QUICK COUPLER KEYS WITH MATCHING HOSE SWIVELS.

  24. SYSTEM IS DIAGRAMMATIC TO IMPROVE CLARITY, ALL MAINLINE PIPING ELECTRIC VALVES AND WIRING ARE TO BE INSTALLED IN LANDSCAPE AREAS AND WITHIN PROPERTY BOUNDARDES. CONTRACTOR SHALL REFERENCE THE LANDSCAPE PLAN PRIOR TO THE INSTALLATION OF PIPING TO AVOID CONTACT WITH PLANT MATERIALS EXISTING OR VIEW. MATERIALS EXISTING OR NEW. 25. CONTRACTOR TO ADD EXTENSION RISER TO POP-UP HEADS WHEN NEEDED FOR
- PROPER COVERAGE.
- 26. CONTRACTOR SHALL INSTALL SPRINKLER EQUIPMENT 12" FROM FOUNDATIONS.
- ALSO INSTALL SPRINKLERS 4" FROM CURB OR WALKS.

  27. PRIOR TO BID IRRIGATION CONTRACTOR SHALL LEFFY RIGHT-OF-WAY AND BACKFLOW REQUIREMENTS. NO LATER THAN FIVE DAYS BEFORE BID SUBMITTALS CONTRACTOR SHALL NOTIFY CONSULTANT OF ANY CHANGES FROM

- SUBMITTALS CONTRACTOR SHALL NOTIFY CONSULTANT OF ANY CHANGES FROM PLANS AND SPECIFICATIONS.

  RIRIGATION CONTRACTOR SHALL PROVIDE THE OWNER AND LANDSCAPE ARCHITECT WITH A REPRODUCIBLE CROSS MEASURED AS-BUILT DRAWINS OF THE INSTALLED IRRIGATION SYSTEM IN AUTOCAD 2010 FORMAT BEFORE FINAL ACCEPTANCE.

  A 1-YEAR WARRANTY PERIOD SHALL BE PROVIDED FOR SYSTEM AFTER SUBSTANTIAL COMPLETION IS ACCEPTED. START UP AND ADJUSTING OF SYSTEM IN SPRING TIME SHALL BE INCLUDED IN WARRANTY.

  PRIOR TO BID, CONTRACTOR SHALL VERIFY THAT ALL MATERIALS, INSTALLATION PARAMETERS AND OPERATIONS CONFORM TO ALL APPLICABLE CODES AND ORDINANCES. NO LATER THAN FIVE DAYS BEFORE BID SUBMITTALS CONTRACTOR SHALL NOTIFY IRRIGATION CONSULTANT/DESIGNER OF ANY CHANGES REDUIRED DUE TO CURRENT CODE OR ORDINANCE DISCREPANCIES. IF CONTRACTOR DOES NOT COMPLY TO THIS NOTIFICATION, THE CONTRACTOR SHALL BE RESPONSIBLE FOR ALL NECESSARY INSTALLATION CHANGE AND REDESIGN COSTS FOR NON-COMPLIANCE. REDESIGN COSTS FOR NON-COMPLIANCE.
- 31. UNLESS OTHERWISE NOTED. THE CONTRACTOR MUST COMPLETE 2 PRESSURE TESTS OF THE IRRIGATION SYSTEM MAINLINE (BOTH TO SHOW NO DROP IN PRESSURE DURING DURATION OF TEST 2-HOUR PRESSURE TEST AT 1.5 TIMES THE SYSTEM STATIC PRESSURE
- A 2-HOUR PRESSURE TEST AT THE SYSTEM STATIC PRESSURE B. 24-HOUR PRESSURE TEST AT THE SYSTEM STATIC PRESSURE IRRIGATION INSTALLATION CONTRACTOR SHALL PROVIDE OWNER WITH A COLOR-CODED ZONES DIAGRAM PLAN, 8-1/2"X11" LAMINATED SHEET(S), TO IDENTIFY CONTROLLER STATION TO THE CONTROL VALVE NUMBER FOR EACH CONTROLLER. TO BE LOCATED IN ADHESIVE POUCH ATTACHED INSIDE OF CONTROLLER.



Seal:

11.26.14 Date: 2014-011 Project No ICS

Drawn By: Checked By (1)  $\mathbf{Q}$ ca

Š and Government Athens, Georgia s-Clarke County Unified G 293 Hoyt Street Athens, GA 30606 Froi House -Lyndon Ġ ar

Irrigation Plan

I 01


Sheet Title

NORTH

Scale: 1" = 10'-0"

20'

10'

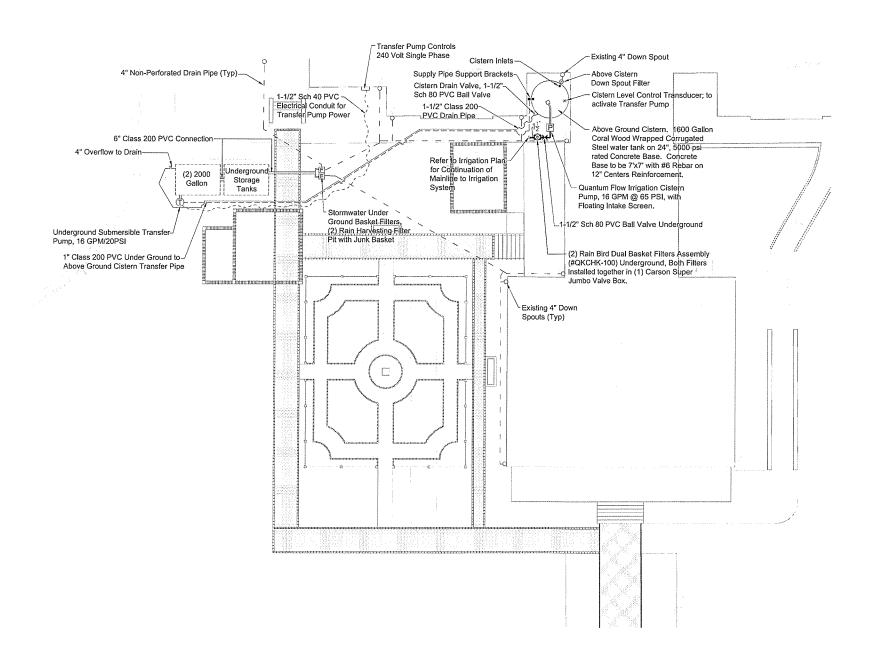



11.26.14 2014-011 ICS

# Checked By:

Ware-Lyndon House Front Landscape
Athens, Georgia
Athens-Clarke County Unified Government
293 Hoyt Street
Athens, GA 30606

NO. DATE DESCRIPTION




Scale: 1" = 10'-0"


0' 5' 10'

Irrigation Water Harvesting Plan

Sheet No:


102

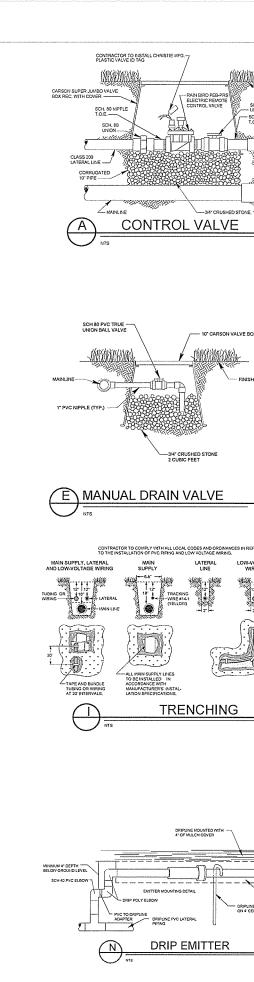


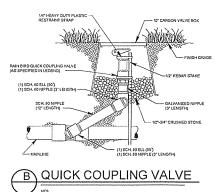



CONTROLLER


RAIN SENSOR

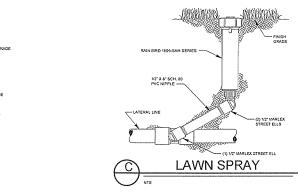


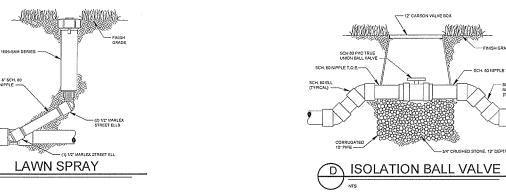

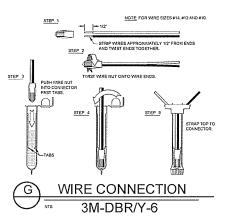


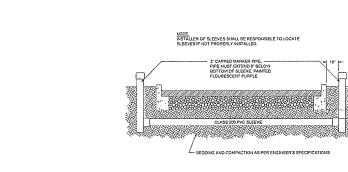

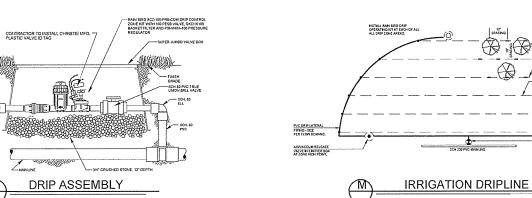


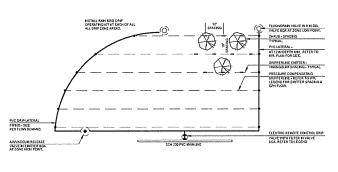


SLEEVING

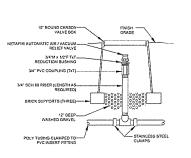

AIR/VACUUM RELIEF

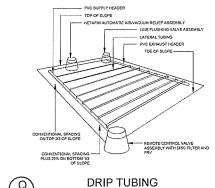

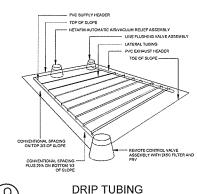

DRIP TUBING SLOPED FEED LAYOUT Root design studio a ren ds ceape a ren ds ceape a ren ds ceape a ren ds ceape


11.26.14 2014-011 Project No ICS Drawn By: Checked By:


Ware-Lyndon House Front Landscape
Athens, Georgia
Athens-Clarke County Unified Government
293 Hoyt Street
Athens, GA 30606


Sheet Title: Irrigation Details


Sheet No:

103

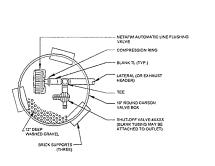

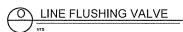

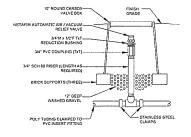

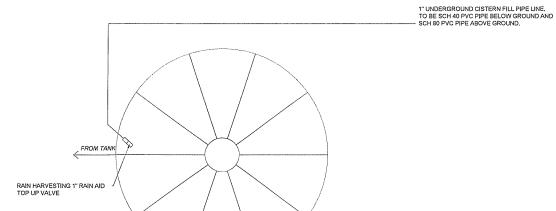



1-1/2" SCH 80 PVC INTAKE FROM CISTERN TANK

1" SCH 80 PVC DISCHARGE TO IRRIGATION SYSTEM

~1-1/2" SCH 80 PVC INTAKE FROM CISTERN TANK


VARIOUS VIEWS OF PUMP UNIT LOCATED INSIDE ENCLOSURE

QUANTUM FLO MODEL #QFA 120/206 240 VAC, SINGLE PHASE POWER

RAIN HARVESTING RAIN AID TOP UP VALVE NOTE:

IRRIGATION INSTALLER SHALL INSTALL A 1" UNDERGROUND CISTERN IRRIGATION INSTALLER SHALL INSTALL A "UNDERGROUND CISTERN TRANSFER WATER PIPE TO THE ABOVE GROUND CISTERN WATER PIPE HARVESTING TANK. THEN INSTALL A RAIN HARVEST SYSTEM 1" RAIN AID TOP UP VALVE TO TURN ON THE UNDERGROUND CISTERN TRANSFER PUMP 6" FROM THE BOTTOM OF THE TANK, THEN ALSO TURN OFF THE TRANSFER WATER 24" FROM THE BOTTOM OF THE TANK.

INSTALLER SHALL INSTALL A TOP UP VALVE IN THE TANK ON TOP OF THE TANK TOP ACCESS COVER. THIS WILL GIVE THE INSTALLATION A 4" - 6" AIR GAP FOR UNDERGROUND CISTERN TRANSER WATER.

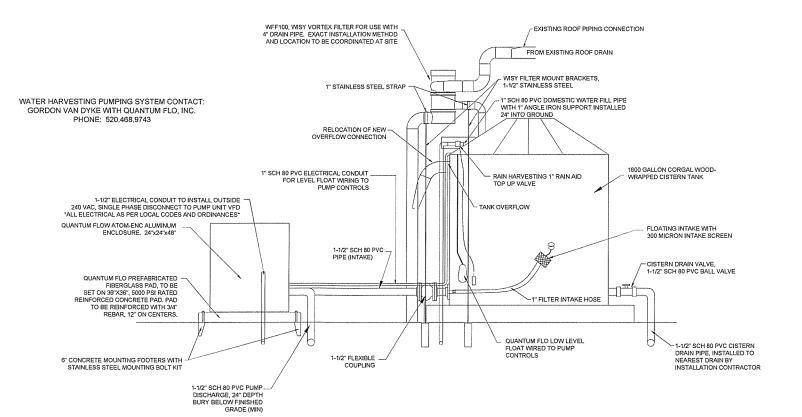



CISTERN PUMPING UNIT (ABOVE GROUND)

design\_studio landscape architecture 404-895-2253

11.26.14

2014-011 Project No Drawn By: ICS Checked By:

Φ are-Lyndon House Front Landscap

Athens, Georgia
Athens-Clarke County Unified Government
293 Hoyt Street
Athens, GA 30606

⋛

Irrigation Water Harvesting Details

PUMP UNIT INFORMATION: QUANTUMFLO WISPERFLO H1 16507-8 ALL SS PUMP MOTOR AND SUPPORT SKID WITH HDPE DROP PIPE DEAD FRONT NEMA 3R CONTROL CABINET INSTALLED LOCALLY 1-1/2" SCH 40 PVC ELECTRICAL CONDUIT— FROM CISTERN PUMPING CONTROL PANEL TO IRRIGATION METER CONTROL VALVE CONTACT GORDON VAN DYKE: 520,468,9743 1" SCH 40 PVC ELECTRICAL CONDUIT FOR LEVEL SENSOR SIGNAL WIRES 2" SCH 40 PVC ELECTRICAL CONDUIT FOR IRRIGATION PUMP POWER WIRE WATER-TIGHT JUNCTION BOX 4" CISTERN OVERFLOW PIPE,— PIPED TO NEAREST DRAIN BY INSTALLATION CONTRACTOR CISTERN MANHOLE COVER, 3 FT /- FINISHED GRADE CONCRETE MANHOLE 1-1/2" SCH 40 PVC ELECTRICAL CONDUIT FROM CISTERN TRANSFER PUMPING CONTROL PANEL TO FLOW METER AND PRESSURE GAUGE SPOOL ASSEMBLY 1" SCH 40 PVC TRANSFER-PIPE TO ABOVE GROUND CISTERN 2000 GALLON NORWESCO BELOW GROUND CISTERN #N-42559 2000 GALLON NORWESCO BELOW GROUND CISTERN #N-42559 PUMP FLOW METER AND PRESSURE -GAUGE SPOOL ASSEMBLY, INSTALLED IN CARSON 24'x36" FIBERGLASS FILLED LEVEL SENSOR AND LEVEL FLOAT -ELECTRICAL J-BOX PLASTIC VAULT VALVE BOX, INSTALLED WITH #57 STONE, 12" DEEP ON TOP OF FILTER FABRIC 6 "CISTERN DRAINAGE PIPE TO TRANSFER PUMP WETWELL STRUCTURE 2" HDPE IRRIGATION 6" CISTERN CONNECTION PIPE PUMP DISCHARGE PIPE. PUMP UNIT SHUT DOWN FLOAT, TO SHUT DOWN UNIT AT 18" WATER DEPTH WEIGHTED SUPPORT STAND IRRIGATION PUMP -LOW LEVEL SHUT DOWN

NOTE: DETAILS ARE NOT DRAWN TO SCALE AND ARE DIAGRAMMATIC FOR READABILITY PURPOSES.





11.26.14 2014-011 ICS Drawn By:

MK Checked By:

Ware-Lyndon House Front Landscape
Athens, Georgia
Athens-Clarke County Unified Government
293 Hoyt Street
Athens, GA 30606

NO. | DATE | DESCRIPTIO

Sheet Title: Irrigation Water Harvesting Details

105

#### **LEGEND**

---- UNDERGROUND CONDUIT.

><PANELBOARD.


TFROC TYPICAL FOR REMAINDER OF CIRCUIT.

#### LIGHTING FIXTURE SCHEDULE


TYPE MANUFACTURER & CATALOG NUMBER

MOUNTING NO./LAMPS LOAD A KIM LIGHTING #EL195-3L3K-UV-DB-H80DB-JBR-3 20" STEM 3/LED ALTERNATE BID #1


TYPE MANUFACTURER & CATALOG NUMBER MOUNTING LOAD NO./LAMPS B KIM LIGHTING #EL195-3L3K-UV-DB-H80DB-JBR-3 20" STEM 3/LED

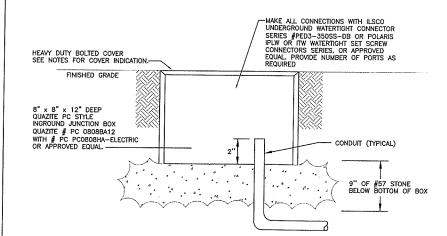

### IN GROUND JUNCTION BOX DETAIL

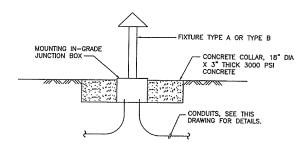

<sup>2</sup> FIXTURE TYPE A & B MOUNTING DETAIL E01 SCALE: NTS

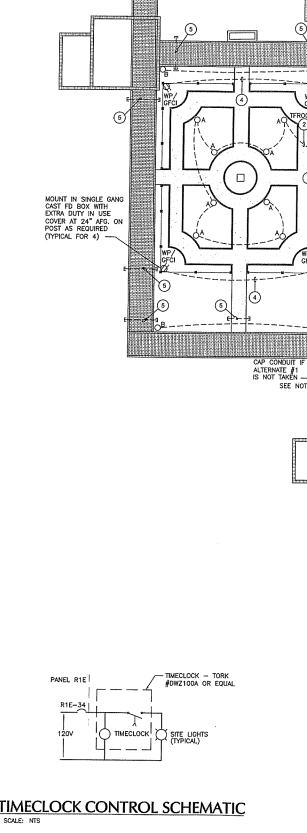

3 TIMECLOCK CONTROL SCHEMATIC

## ELECTRICAL PLAN

2)TFR00

SEE NOTE 3

SEE NOTE 4

SEE NOTE 4

SEE NOTE 2

SEE DETAIL 2/E01 FOR MOUNTING OF FIXTURES ————

CAP CONDUIT II ALTERNATE #1 IS NOT TAKEN

SEE NOTE 3

SEE NOTE 3 -

- INGROUND JUNCTION BOX

□ (5) B(

SEE DETAIL 1/E01 (TYPICAL FOR 3)

SEE NOTE

(1)

(3)

#### **NOTES**

- APPROXIMATE LOCATION OF EXISTING PANEL RIC CONTRACTOR TO VERIFY

SEE NOTE 2


-CAP CONDUIT IF

SEE NOTE 3

(5)

APPROXIMATE LOCATION OF EXISTING PANEL RIE

1. CONTRACTOR TO RUN HOMERUN INTO THE EXISTING HOUSE. IN THE CRAWL SPACE UNDER THE ERST FLOOR AND TURN UP THE ELECTRICAL CLOSET WITH EXISTING PANELS RIC AND RIE. TERMINATE THE OUTLET CIRCUITS IN PANEL RIE, UNDER SPARE 20A/1POLE CIRCUIT BREAKER, CIRCUITS RIE-26,28,30,32. TERMINATE THE LIGHTING CIRCUIT UNDER SPARE 20A/1POLE CIRCUIT BREAKER RIE-34 VIA NEW TIMECLOCK. LOCATE NEW TIMECLOCK ESSIDISE SISTING PANEL RIE. NOTE ADDITIONS TO THE PANELBOARD SCHEDULE.

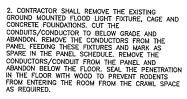

3. THE CONTRACTOR SHALL PROVIDE AN ADDITIVE 3. THE CONTRACTOR SHALL PROVIDE AN ADDITIVE COST FOR ALTERNATE #1 WHICH WILL INCLUDE THE TOTAL COST FOR INSTALLATION OF ALL TYPE B FIXTURES INCLUDING COMPLETE COST FOR THE WIRING AND COMPLET INSTALLATION AND COMPLETE COST FOR THE FIXTURES TYPE B WITH INSTALLATION. IF ALTERNATE #1 IS NOT TAKEN, REFER TO THE DOCUMENTS AS TO WHERE THE EMPTY CONDUITS WILL BE INSTALLED AND CAPPED FOR THE FUTURE.

4. THE CONTRACTOR SHALL PROVIDE AN ADDITIVE COST FOR THE INSTALLATION ON ALTERNATE #2 WHICH WILL INCLUDE THE TOTAL COST OF THE FOUR 120V GFCI OUTLETS AND WIRING FROM THE INGROUND JUNCTION BOX TO THE FOUR OUTLET LOCATIONS. COST TO BE COMPLETE FOR WIRING CONDUCTORS CONTRACTORS CONTRA CONDUCTORS/CONDUITS) AND THE OUTLETS/OUTLET BOXES AND COVERS, IF ALTERNATE #2 IS NOT TAKEN BY THE OWNER, THE CONTRACTOR SHALL STUB OUT OF THE INGROUND JUNCTION BOX WITH 2 — 3/4" EMPTY CONDUITS (CAP CONDUITS) TO APPROXIMATELY 3 LF OFF THE EDGE OF THE BOX FOR FUTURE EXTENSIONS OF THE POWER OUTLET CIRCUITRY.

#### **WIRING SCHEDULE**

1) 10#8 + 1#8G IN 1 1/4" C.

3 4#8 + 1#8G IN 3/4" C.

4 2#8 + 1#8G IN 3/4" C.

0' 5'





01-05-2015 2014-011 AP/CP WKMW Checked By:

Φ <u>ā</u>

Landsca Front

Athens, Georgia s-Clarke County Unified Go 293 Hoyt Street Athens, GA 30606

Athens-

2) 2#12 + 1#12G IN 3/4" C.

5 2" EMPTY CONDUITS CAP BOTH ENDS (REMOVABLE)

ALL CONDUCTORS ARE TO BE COPPER



NORTH

201



**ELECTRICAL PLAN** 

W&A PROJECT NUMBER -14080 2300 Lake Park Dr, Suite 250 Smyrna, Georgia 30080 Voice 770-458-3005 Fax 770-458-8388

Scale: 1" = 10'-0"

10'

E 01